

REVISIONS:

COV PROPERTIES

1581-1585 W. 4TH AVE., VANCOUVER, BC

McCUAIG & ASSOCIATES ENGINEERING LTD.

#201 - 33 East 8th Avenue Vancouver, BC, V5T 1R5 Phone: 604-255-0992 Fax: 604-255-1054

ONLY VALID
FOR CONSTRUCTION
WHEN SEALED AND SIGNED

SHEET TITLE:

EXISTING ROOF PLAN

 SCALE:
 1/4" = 1'-0"

 DRAWN BY:
 GC


 DRAWN ON:
 DATE


 CHECKED BY:
 AL/PC

 PROJECT #:
 20171104

NOTE: FIELD VERIFY ALL MEASUREMENTS: DO NOT SCALE OFF DRAWINGS

ISSUED FOR: 100% DESIGN ON FEB 26, 2018

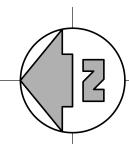

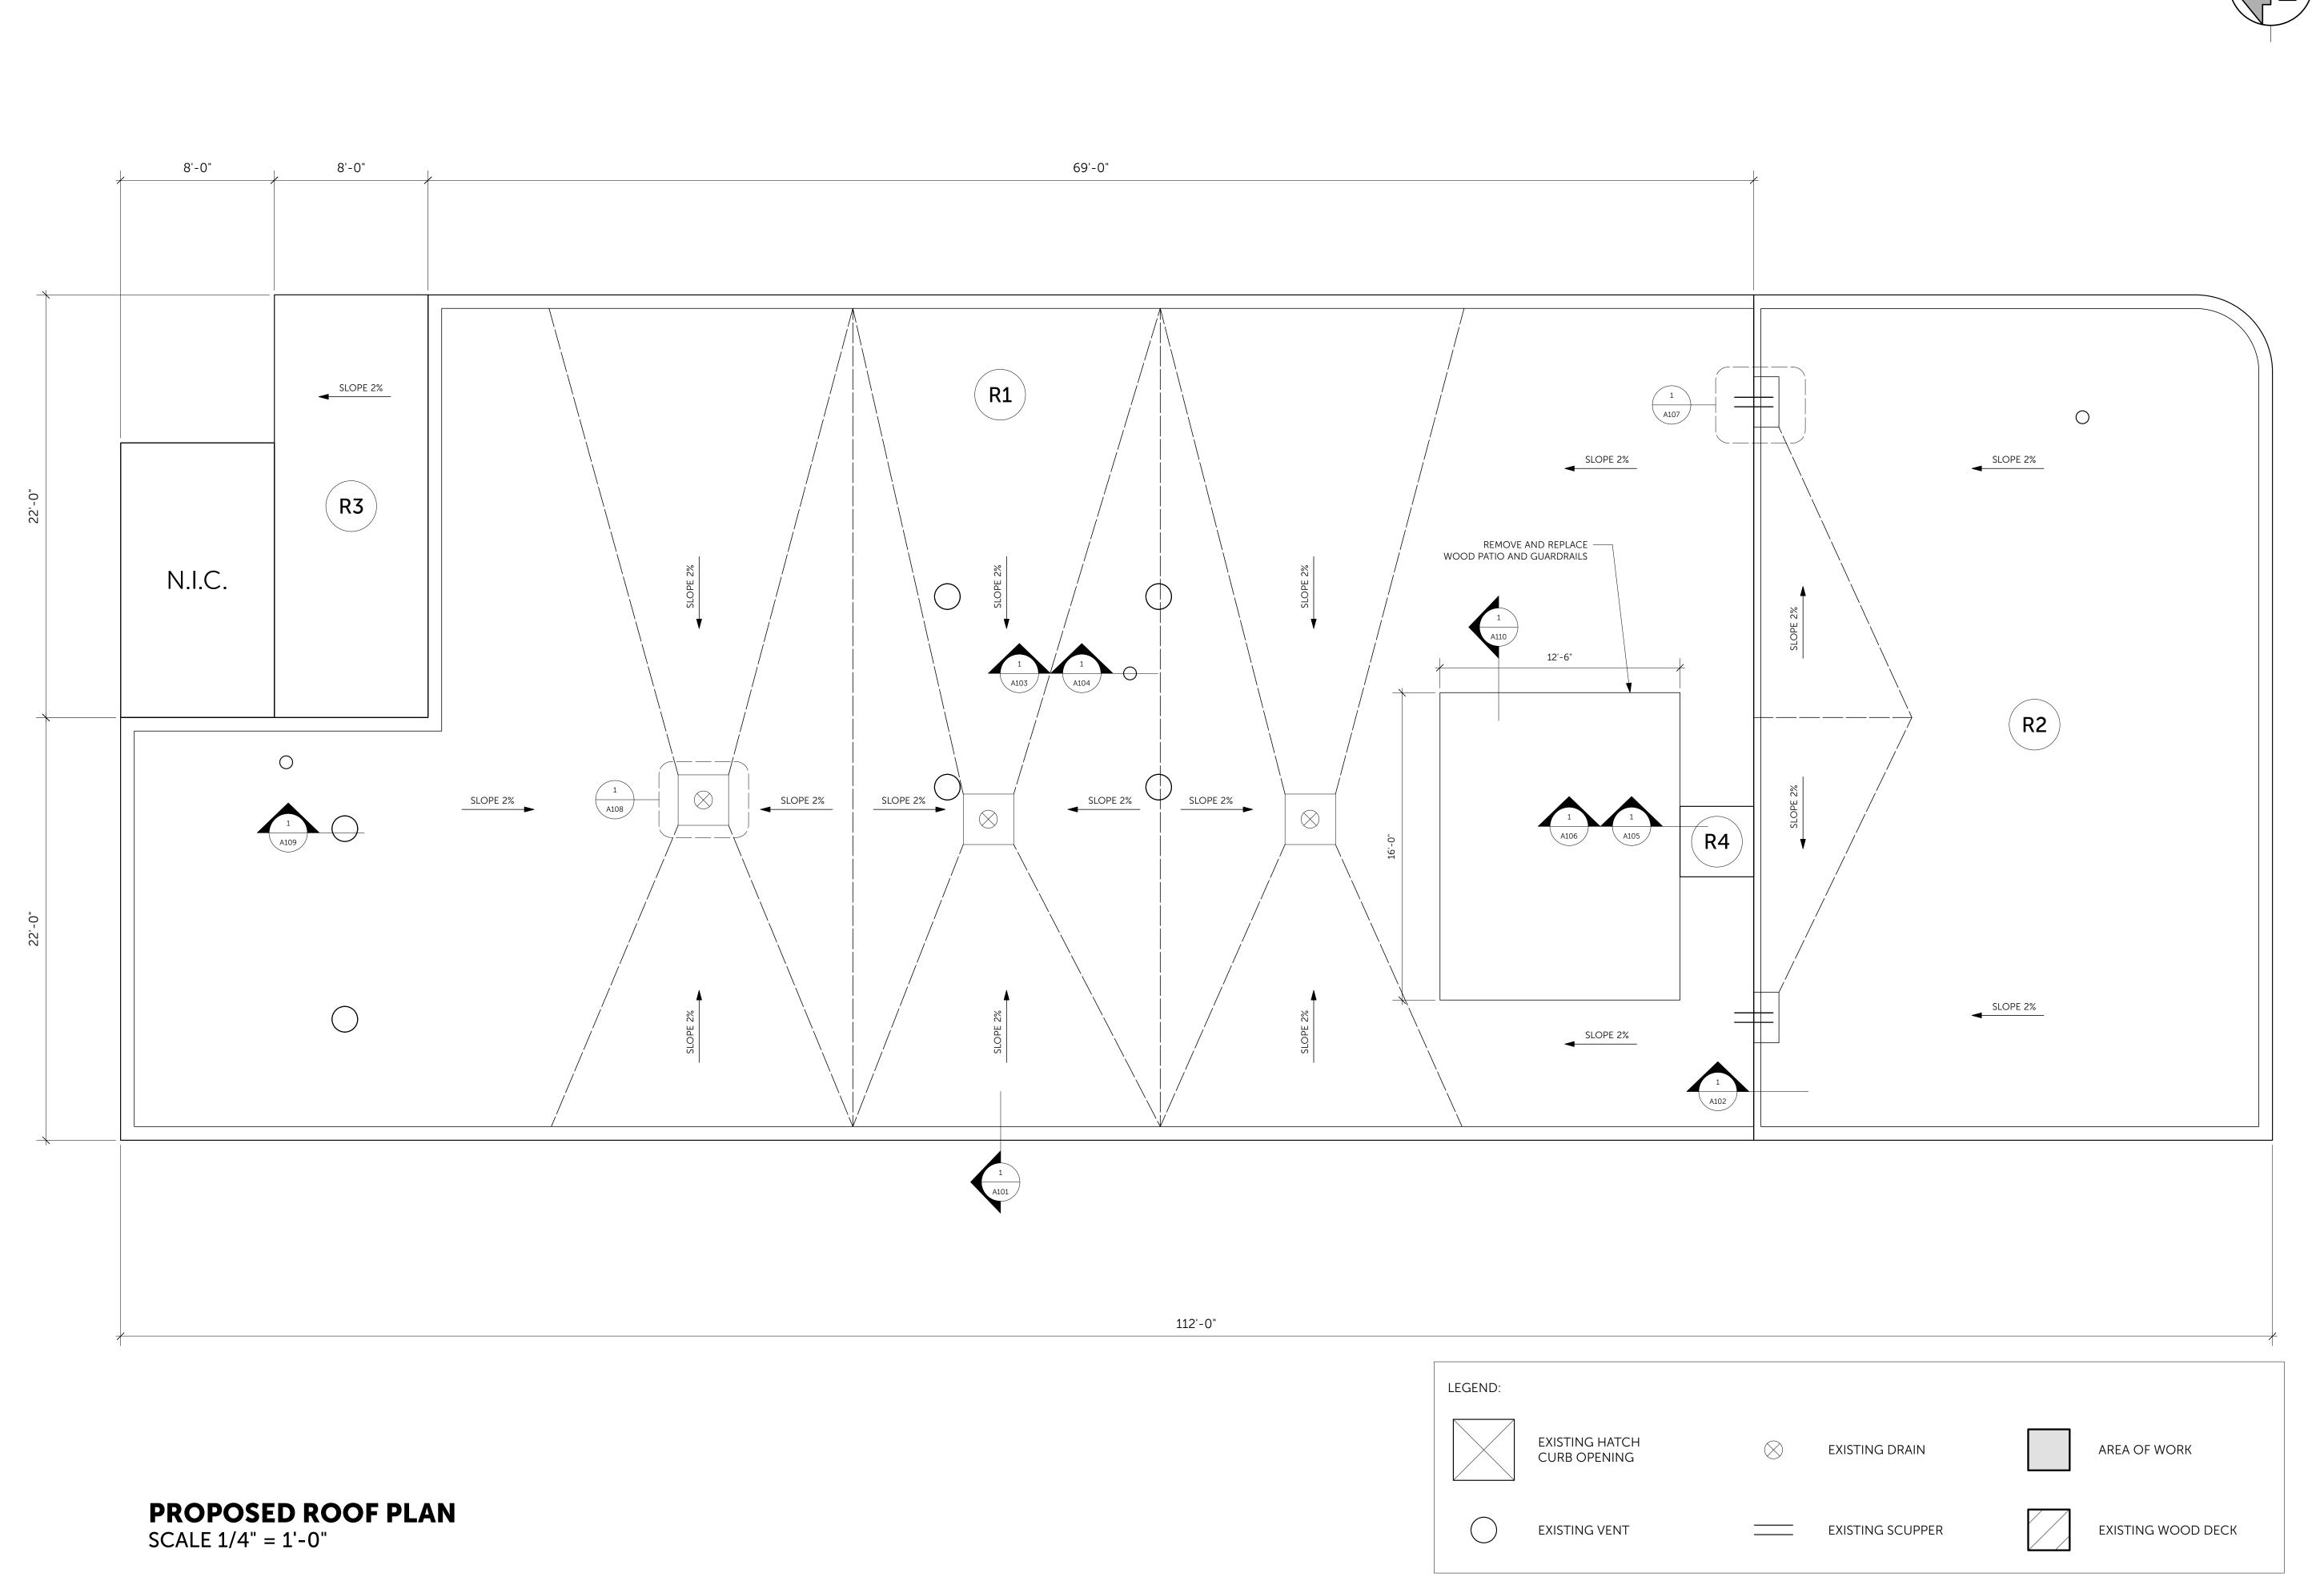

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SHEET TITLE:

PROPOSED ROOF PLAN

SCALE: 1/4" = 1'-0"

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DRAWN ON: DATE


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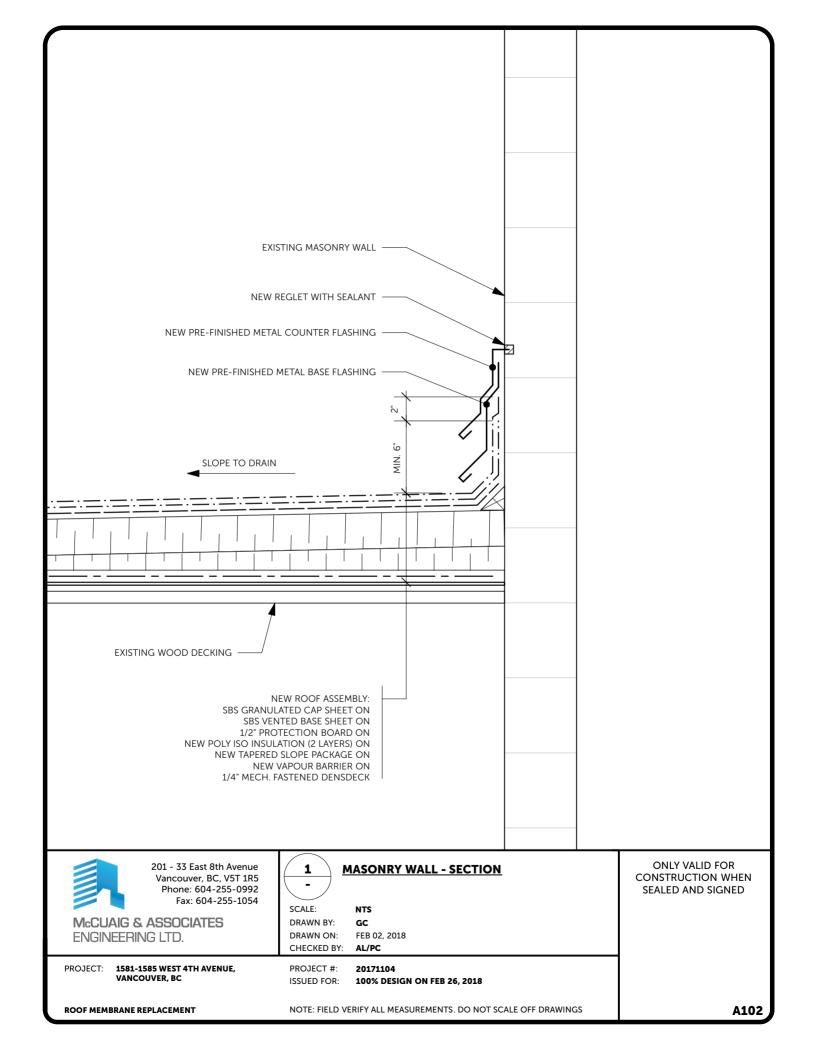
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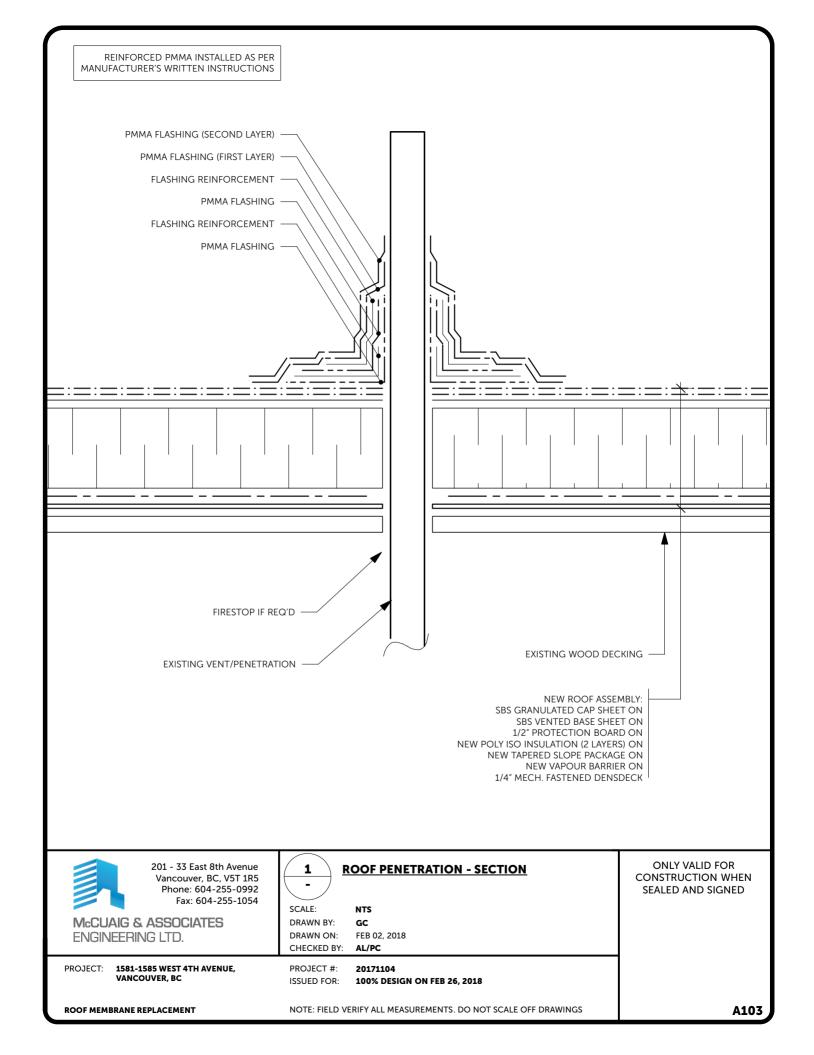
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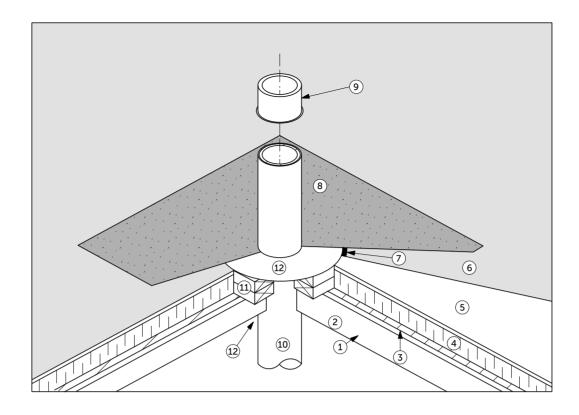
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A003







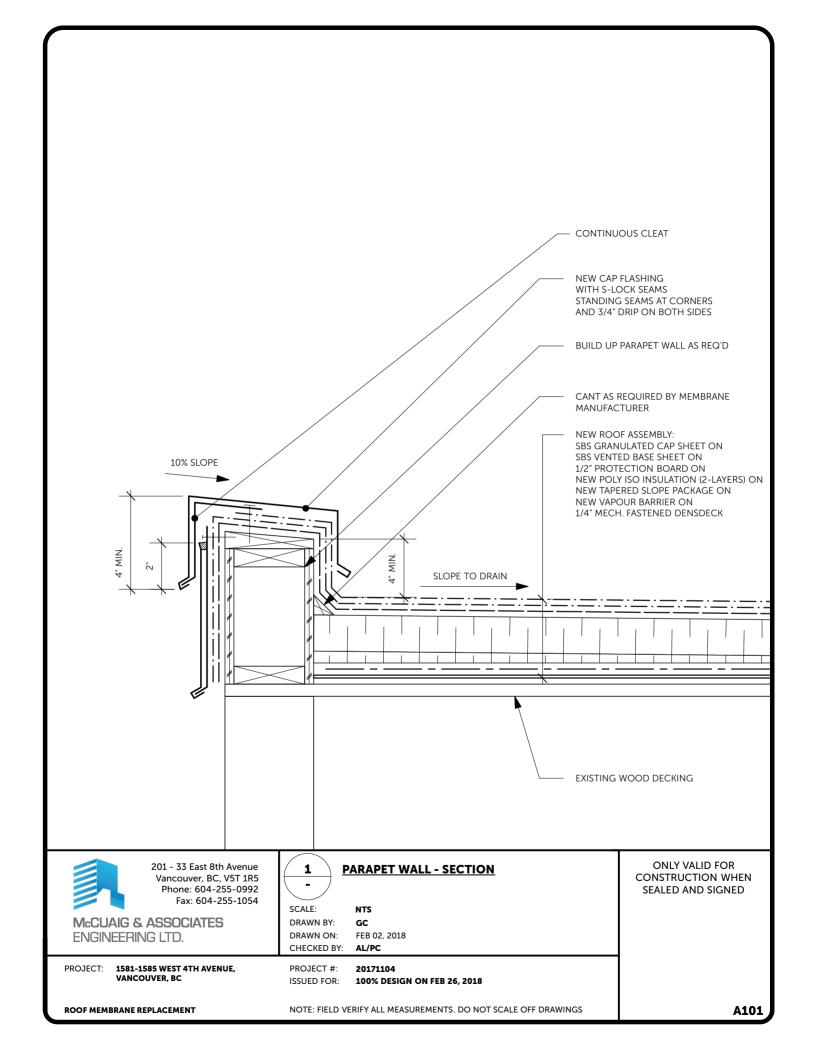

- 1 WOOD DECK
- 2 COVERBOARD
- 3 VAPOUR RETARDER
- 4 INSULATION
- 5 PROTECTION BOARD
- 6 PRIMARY MEMBRANE AND MEMBRANE PROTECTION
- 7 MASTIC
- 8 MEMBRANE FLASHING
- 9 TYPICAL LEAD CAP
- 10 PLUMBING STACK
- 11 WOOD BLOCKING
- 12 METAL FLASHING
- 13 FIRESTOP AS REQUIRED



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PROJECT: 1581-1585 WEST 4TH AVENUE,

VANCOUVER, BC

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MECH/HATCH OPENING - SECTION

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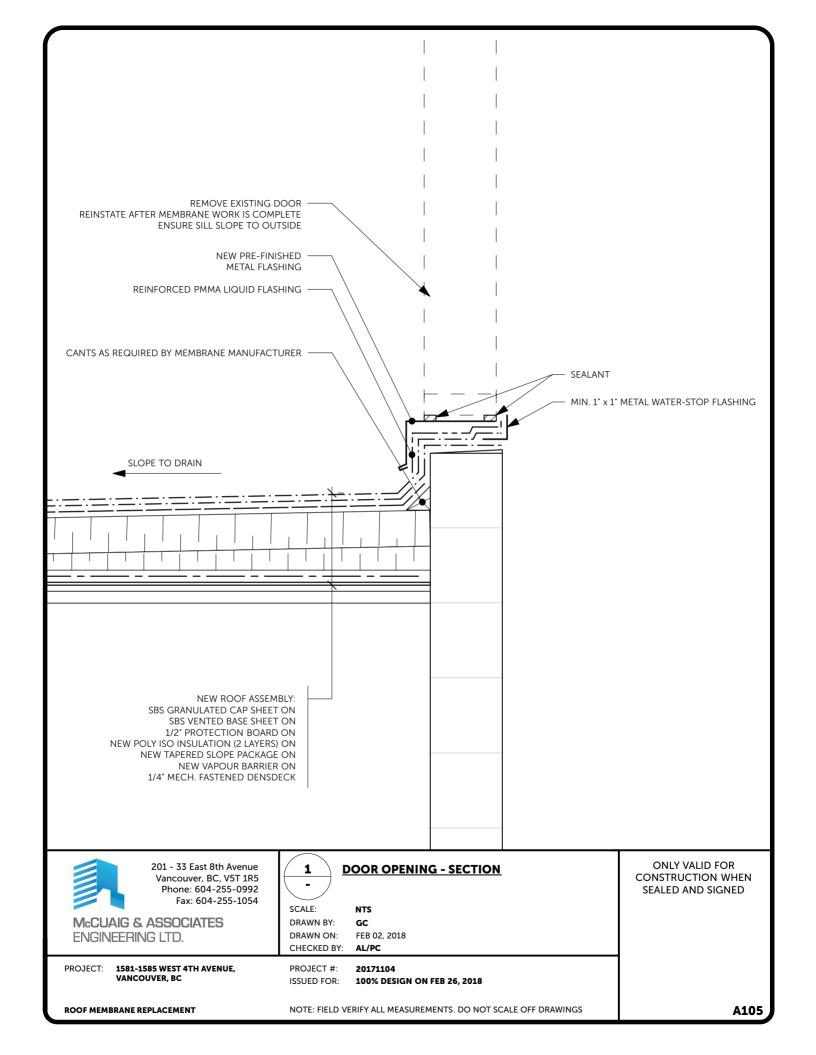
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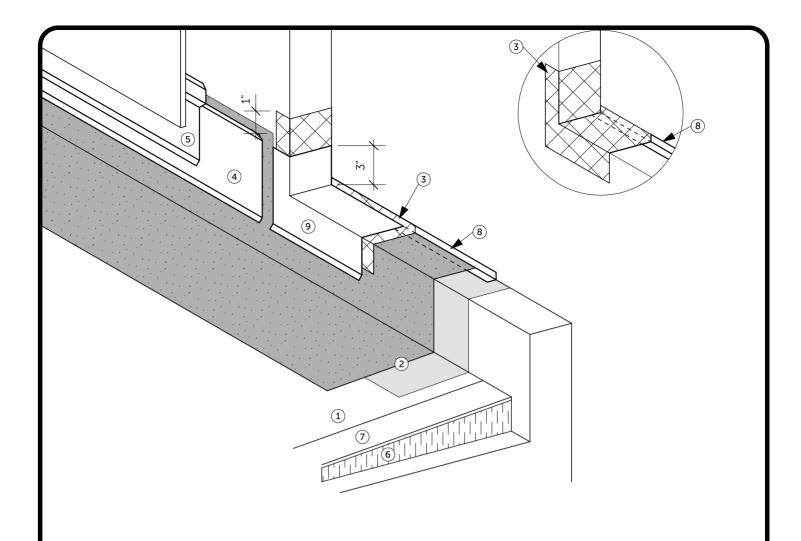
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ROOF MEMBRANE REPLACEMENT

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- PRIMARY MEMBRANE
- MEMBRANE FLASHING LAP CAP STRIPPING OVER BASE STRIPPING AS REQUIRED BY MEMBRANE MANUFACTURER. 2 INSTALL MEMBRANE GUSSETS AT CORNERS.
- 3 REINFORECED PMMA LIQUID FLASHING - ALONG DOOR SILL AND UP CORNERS. SEAL METAL WATER-STOP FLASHING.
- METAL BASE FLASHING TO BE CONTINOUS WITH METAL PAN SILL FLASHING 4
- 5 METAL COUNTER FLASHING
- 6 INSULATION
- **INSULATION OVERLAY** 7
- METAL WATER-STOP FLASHING MIN. 1" X 1" ATTACHED TO INSIDE OF DOOR SILL FRAMING 8 CUT FLASHING TO FIT OPENING AND INSTALL MEMBRANE GUSSETS AT CORNERS. SEALED WITH MEMBRANE FLASHING.
- METAL PAN SILL FLASHING METAL PAN WITH WATER STOP FORMED WITH PAN FOLD WELDED OR SOLDERED CORNERS MECHANIALLY ATTACHED TO INSIDE OF DOOR SILL FRAME.



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LOW DOOR SILL DETAIL

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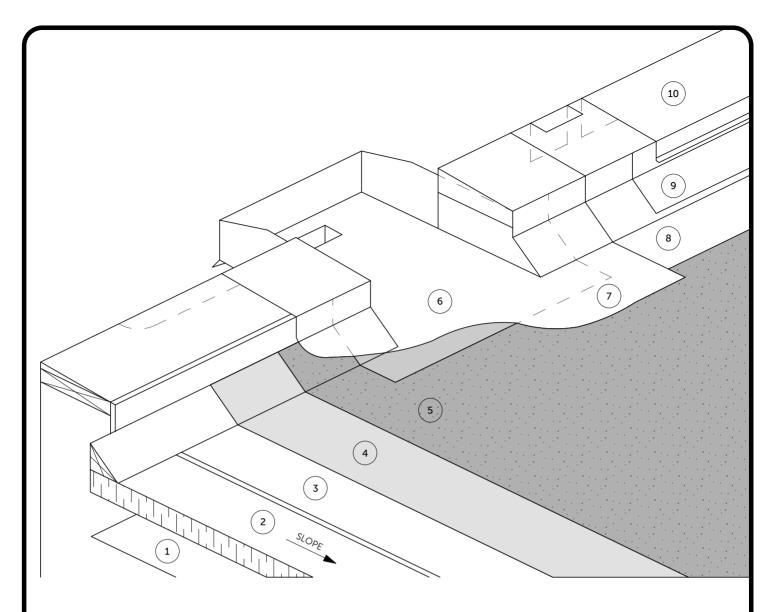
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ROOF MEMBRANE REPLACEMENT

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OVERFLOW SCUPPER DETAIL

WORK INCLUDED:

- 1) VAPOUR RETARDER
- 2) SLOPED INSULATION PACKAGE
- 3) INSULATION OVERLAY
- 4) BASE SHEET
- 5) CAP SHEET
- 6) METAL SCUPPER WITH HOPPER: THE OUTSIDE FACE OF SCUPPER TO BE 37.7mm (1 1/2") LOWER THAN THE BOX HEIGHT WITH A 12.7MM (1/2") DRIP EDGE. INSTALLED IN A THIN BED OF COMPATIBLE MASTIC. INTERFACE BETWEEN OUTSIDE WALL AND SCUPPER SHOULD BE CAULKED WITH APPROPRIATE SEALANT. INSTALLED WHEN WALL FINISH IS COMPLETE PRIOR TO COMPLETION OF ROOFING.
- 7) SCUPPER MEMBRANE FLASHING
- 8) MEMBRANE FLASHING
- 9) METAL BASE FLASHING: MECHANICALLY FASTENED.
- 10) METAL CAP FLASHING: FASTEN WITH CONTINUOUS CONCEALED CLIP-TYPE FASTENERS OR CLADDING SCREWS EVENLY SPACED BETWEEN SEAMS. S-LOCK SEAMS. STANDING SEAMS AT CORNERS WITH 3/4" DRIP ON BOTH SIDES. CONTINUOUS CLEAT ON OUTSIDE FACE.



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BOX SCUPPER DETAIL

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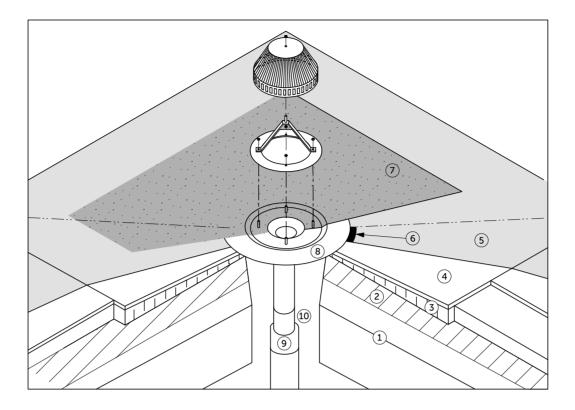
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ROOF MEMBRANE REPLACEMENT

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- **EXISTING DECK** 1
- VAPOUR BARRIER
- INSULATION 3
- **INSULATION OVERLAY**
- PRIMARY MEMBRANE AND MEMBRANE PROTECTION
- MASTIC COMPATIBLE MASTIC ACCEPTED BY MEMBRANE MANUFACTURER 6
- MEMBRANE FLASHING
- NEW ROOF DRAIN ASSEMBLY WITH APPROVED BLUE SEAL MECHANICAL JOINT
- MENZIE BLUE SEAL OR APPROVED EQUIVALENT 9
- 10 FIRE STOP AS REQUIRED



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DRAIN DETAIL

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